

ORDINANCE NO. 001-2024

AMENDING THE ZONING MAP ATTACHED TO CHAPTER 1104.01 OF THE 2023 CODIFIED ORDINANCES OF THE CITY OF WHITEHALL, OHIO AND AS SUBSEQUENTLY AMENDED, ALLOWING A SPECIAL PERMIT UNDER SECTION 1104.03(H) TO PERMIT BUY & BUY AUTO SALE, LLC COMPANY TO OPERATE A VEHICLE AND LARGE EQUIPMENT REPAIR BUSINESS IN THE MAIN STREET DISTRICT.

WHEREAS, Council has received an application from Buy & Buy Auto Sale, LLC for a Special Permit to operate a vehicle and large equipment repair business in the Main Street Corridor District; and

WHEREAS, Said request for a Special Permit was referred to the Planning Commission (Case No. 876), which reported _____ on said request; and

WHEREAS, Council has held a Public Hearing after due notice according to law; NOW, THEREFORE,

BE IT ORDAINED BY THE COUNCIL OF THE CITY OF WHITEHALL, OHIO:

SECTION 1: That the Zoning Map attached to Chapter 1104.01 of the 2023 Codified Ordinances for the City of Whitehall, Ohio and as subsequently amended, be and the same is hereby amended by allowing a special permit under 1104.03(H) for the following described premises, to wit:

(SEE PRELIMINARY SITE PLAN ATTACHED OF THE PROPERTY)

SECTION 2: That said Special Permit is granted on the following conditions pursuant to Section 1125.04(H)(1) and Section 1125.04(H)(2) of Codified Ordinances.

1. A special use permit shall automatically expire if the permitted use has not been established or utilized within one year of the date on which the special use permit was issued unless the City Council grants an extension.
2. A special use permit shall automatically expire if for any reason the permitted use ceases operation for more than 12 consecutive months.

SECTION 3: That the Director of Public Service is hereby authorized and directed to proceed with the prescribed Ordinance directing the City Engineer to change the Official Zoning Map of the City of Whitehall.

SECTION 4: That this ordinance shall take effect and be in force from the earliest period allowed by law.

PASSED this ____ day of _____, 2024.

ATTEST:

Clerk of Council

President of Council



APPROVED this ____ day of _____, 2024.

Mayor

Requested by: Applicant


Approved as to form by: Bradley S. Nicodemus, Assistant City Attorney BSN 12/28/2023



Parking

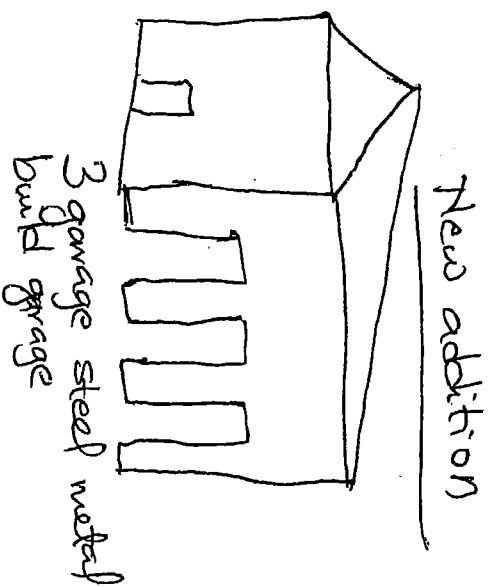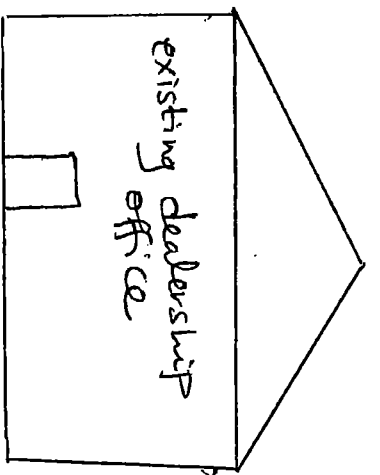

Dealer lot

4333 E Main St

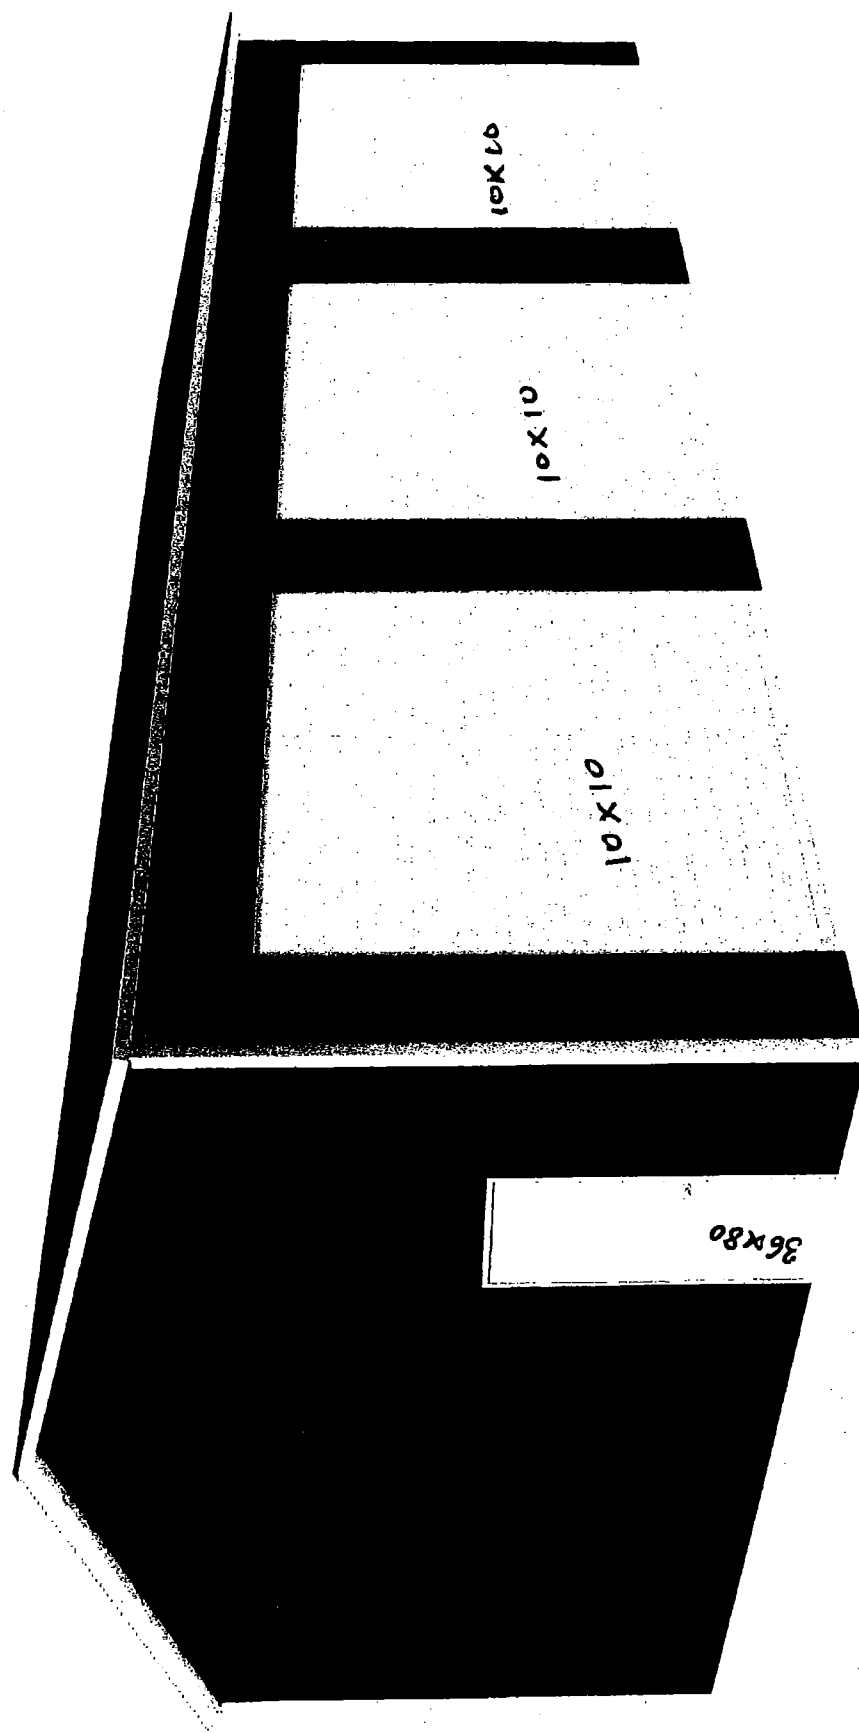

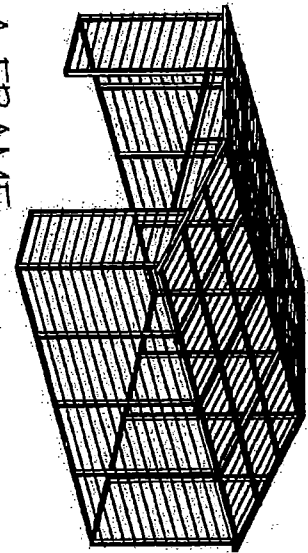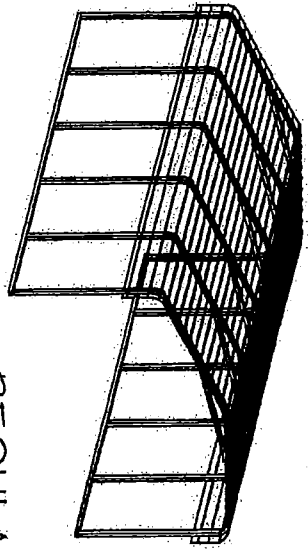

REGULAR / A-FRAME 26'-0" WIDE

CARPORT STYLE BUILDINGS

DESIGN NOTES

1. ALL CONSTRUCTION SHALL BE PROVIDED IN ACCORDANCE WITH IRC 2015, OSHA, ASCE 360, AISI 100, ASCE 7-10, AWS D13 CODES AND ALL APPLICABLE LOCAL REQUIREMENTS.
2. ALL MATERIALS IDENTIFIED BY MANUFACTURER NAME MAY BE SUBSTITUTED WITH MATERIAL EQUAL OR EXCEEDING ORIGINAL.
3. ALL SHOP CONNECTIONS SHALL BE WELDED CONNECTIONS.
4. ALL STRUCTURAL FIELD CONNECTIONS SHALL BE #12-14 X 3/4" SD5 (ESR-2196 OR EQ) WITHOUT WASHERS.
5. STEEL SHEATHING SHALL BE 29GA CORRUGATED GALV. OR PAINTED STEEL - MAIN RIB HT. 3/4" (FY=48KSI) OR EQ. CONNECTIONS SHALL BE #12-14 X 3/4" SD5 (ESR-2196 OR EQ) WITH NEOPRENE WASHERS.
6. ALL STRUCTURAL LIGHT GAUGE TUBING AND CHANNELS SHALL BE GRADE 50 STEEL (FY = 50 KSI, FU = 65 KSI).
7. STRUCTURAL TUBE 2 1/2" X 2 1/2" - 14GA IS EQUIVALENT TO 1S, 2 1/2" X 2 1/2" - 12GA AND EITHER ONE MAY BE USED IN LIEU OF THE OTHER.
8. GYPSUM BOARD OR DRYWALL FINISH OR ANY BRITTLE BASE MATERIAL IS NOT CONSIDERED OR ACCOUNTED FOR ON THE DESIGN CRITERIA.
9. ALL DESIGN CRITERIA MUST BE INCREASED TO THE NEXT HIGHER INCREMENT BASED ON THE TABLES ON PAGE 4. NO INTERPOLATION IS ALLOWED.

DESIGN CRITERIA

PREVAILING CODE: 2017 IBC (IBC 2015)
USE GROUP: U (CARPORTS, BARNS)
RISK CATEGORY: I

DRAWING INDEX

COVER SHEET
SCHEDULES & MEMBER-
SECTIONS

1

1. DEAD LOAD (D) D = 4 PSF
2. ROOF LIVE/SNOW LOAD (Lr)
Lr = 20 - 61 PSF
(AS PER SNOW LOAD
SEE TABLE 4)

FRAME SECTIONS & DETAILS
SPACING SCHEDULES -
& ENCLOSURE NOTES
PURLIN & GIRT SCHEDULES
SHEATHING OPTIONS
SIDE WALL FRAMING
& OPENINGS
END WALL FRAMING
& OPENINGS
CORNER BRACING DETAILS
OPTIONAL LEAN-TO ADDITION
FOUNDATION OPTIONS

2
3
4
5
6

3. SNOW LOAD (S)
GROUND SNOW LOAD Pg = 20 - 90 PSF
IMPORTANCE FACTOR Is = 0.8
THERMAL FACTOR Ct = 12
EXPOSURE FACTOR Ce = 10
ROOF SLOPE FACTOR Cs = 1.0
WIND LOAD (W)
BASIC WIND SPEED Vbrt = 105 - 180 MPH
EXPOSURE C
SEISMIC LOAD (E)
DESIGN CATEGORY D
IMPORTANCE FACTOR Ie = 1.00

7-A, 7-B
8-A, 8-B
9
10
11-A TO 11-D

LOAD COMBINATIONS:

1. D + (Lr OR S)
2. D + (0.6W OR ±0.7E)
3. D + 0.75 (0.6W OR ±0.7E) + 0.25 (Lr OR S)
4. 0.6D + (0.6W OR ±0.7E)

CUSTOMER INFORMATION

OWNER:
ADDRESS:

DESIGN LOADS

GROUND SNOW:

ROOF LIVE LOAD:

BASIC WIND SPEED:

BUILDING INFORMATION

WIDTH:

LENGTH:

HEIGHT:

FRAME TYPE:
☐ A-FRAME
☐ REGULAR

ENCLOSURE
TYPE:
☐ FULL
☐ PARTIAL
☐ OPEN

CERTIFICATION VALIDITY NOTICE

DATE OF PLANS: 01-26-2024

CERTIFICATION ON THESE DRAWINGS IS
VALID FOR ONE YEAR FROM DATE OF ISSUE

MANUFACTURED BY:



457 N. Broadway,
Joshua, TX 76068
1-866-730-9865



A&A ENGINEERING
CIVIL - STRUCTURAL
6136 Bendway Pkwy, Toledo, OH 43623
TEL: 419-292-1985 • Fax: 419-292-0055
www.aandengineering.com

DRAWING INFORMATION

PROJECT: 26'-0" WIDE BUILDINGS

LOCATION: STATE OF OHIO

PROJECT NO.: 033-23-0120

SHEET TITLE:

COVER SHEET

SHEET NO.: 1 / 11


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CHECKED BY: OVA DATE: 1/24/22

LEGAL INFORMATION

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- DRAWINGS VALID UP TO DATE OF EXPIRATION.

SEAL:

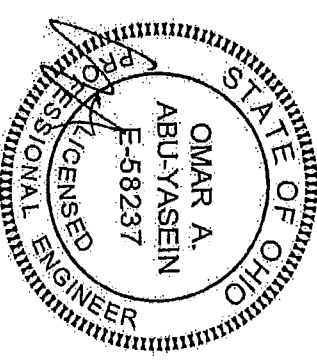

STAMP EXPIRY: 12-31-2023

DATE SIGNED: 01-26-2023


TABLE 2.1: MEMBER PROPERTIES

NO.	LABEL	PROPERTY	DETAIL NO.
1	COLUMN POST	2.5" X 2.5" X 14GA TUBE W/ 2.25" X 2.25" X 12GA TUBE INSERT	11
2	ROOF BEAM	2.5" X 2.5" X 14GA TUBE	1
3	BASE RAIL	2.5" X 2.5" X 14GA TUBE	1
4	PEAK BRACE	2.5" X 2.5" X 14GA TUBE	1
5	KNEE BRACES	2.5" X 1.5" 14GA CHANNEL	4
6	CONNECTOR SUBEYE	2.25" X 2.25" X 12GA TUBE	2
7	BASE ANGLE	2" X 2" X 3/16" LG. 14GA ANGLE	10
8	PURLIN	4.25" X 1.5" X 18GA / 14GA HAT CHANNEL	5
9	GIRT	4.25" X 1.5" X 18GA / 14GA HAT CHANNEL	5
10	SHEATHING	29 GA CORRUGATED SHEET	8
11	END WALL POST	2.5" X 2.5" X 14GA TUBE	1
12	DOOR POST	2.5" X 2.5" X 14GA TUBE	1
13	SINGLE HEADER	2.5" X 2.5" X 14GA TUBE	1
14	DOUBLE HEADER	DBL 2.5" X 2.5" X 14GA TUBE	1
15	SERVICE DOOR / WINDOW FRAMING	2.5" X 2.5" X 14GA TUBE	1
16	ANGLE BRACKET	2" X 2" X 2" LG. 14GA ANGLE	7
17	STRAIGHT BRACKET	2" X 2" X 4" LG. 14GA PLATE	6
18	PB SUPPORT	2.5" X 2.5" X 14GA TUBE	1
19	DIAGONAL BRACE	2" X 2" X 14 GA TUBE	3
20	GABLE BRACE	2" X 2" X 14 GA TUBE	3
21	DB BRACKET	2.25" X 2.25" X 6" X 14GA ANGLE	9
22	TRUSS SPACER	2.5" X 2.5" X 14GA TUBE	1
23	ALL FASTENERS	#12 X 1" SELF-DRILL SCREWS (ESR-2196 OK EQ W/ NEOPRENE/STEEL WASHER	

TABLE 2.2: SHEATHING FASTENER SCHEDULE

LOCATION	CORNER PANELS	SIDE LAP'S	EDGE LAP'S	ELSEWHERE
SPACING	9" C/C	MIN 1	4" C/C	9" C/C


FASTENER TYPE: #12X1" SELF-DRILL SCREWS (ESR-2196 OR EQ) W/ NEOPRENE/STEEL WASHER
 *SEE TYP. SHEATHING FASTENER SCHEDULE DIAGRAM ON PAGE 6.

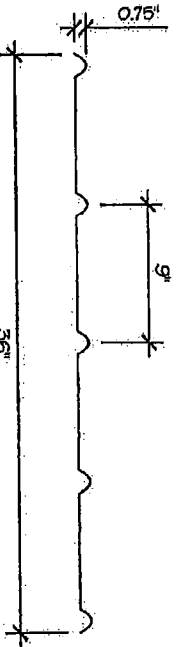

THICKNESS = 29GA


29 GA CORRUGATED SHEATHING

SCALE: NTS

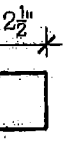


THICKNESS = 14GA

2.5" X 2.5" 14GA TUBE
SCALE: NTS

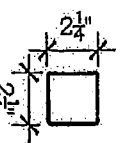


THICKNESS = 12GA

2.25" X 2.25" 12GA TUBE
SCALE: NTS

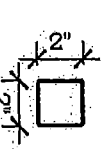


THICKNESS = 14GA

2" X 2" 14GA TUBE
SCALE: NTS

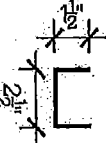


THICKNESS = 14GA

2.5" X 1.5" 14GA CHANNEL
SCALE: NTS

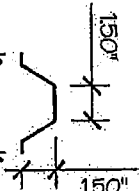

THICKNESS = 14GA / 18GA


4.25" X 1.5" X 18GA / 14GA
HAT CHANNEL
SCALE: NTS

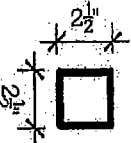

THICKNESS = 14GA


2.5" X 2.5" X 14GA TUBE W/ 2.25" X 2.25" X 12GA TUBE INSERT
SCALE: NTS

NOTE: INSERT FULL LENGTH & FIELD BOLT W/ (25) FASTENERS @ 12" C/C STAGGERED OPPOSITE FACE

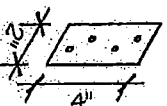


THICKNESS = 14GA

STRAIGHT BRACKET
SCALE: NTS

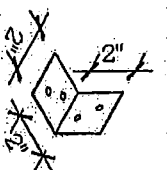

THICKNESS = 14GA


ANGLE BRACKET
SCALE: NTS

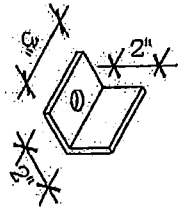

THICKNESS = 3/16"

BASE ANGLE

SCALE: NTS

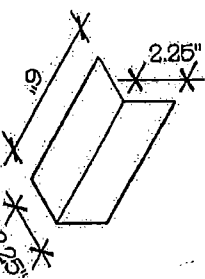

THICKNESS = 14GA

DB BRACKET

SCALE: NTS

MANUFACTURED BY:



457 N. Broadway,
 Joshua, TX 76058
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ENGINEERED BY:



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 6026 Renaissance Blvd., Toledo, OH 43623
 TEL 419-292-1084 • FAX 419-292-6955
 WWW.A&A-ENGINEERS.COM

DRAWING INFORMATION

PROJECT: 26'-0" WIDE BUILDINGS

LOCATION: STATE OF OHIO

PROJECT NO.: 035-23-0120

SHEET TITLE:

SCHEDULES &

MEMBER SECTIONS

SHEET NO.: 2 / 11


DRAWN BY: AW DATE: 1/24/22

CHECKED BY: OAA DATE: 1/24/22

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 DATE SIGNED: 01-26-2023

TABLE 4: FRAME SPACING CHART / SCHEDULE


EAVE HEIGHT - UP TO 6'-0"		EAVE HEIGHT = 7'-0" TO 9'-0"		EAVE HEIGHT = 10'-0" TO 12'-0"		ENCLOSED BUILDINGS										OPEN BUILDINGS									
						WIND SPEED (MPH)										WIND SPEED (MPH)									
						0105	0115	0130	0140	0155	0165	0180	0105	0115	0130	0140	0155	0165	0180						
GROUND SNOW / ROOF LIVE LOAD (PSF)	0105	0115	0130	0140	0155	0165	0180	0105	0115	0130	0140	0155	0165	0180	0105	0115	0130	0140	0155	0165	0180				
30 / 20	60	60	54/60	54	48	42/48	36/42	54/60	48/54	42/54	42/48	36/42	36/42	30/36	54/60	48/54	42/54	42/48	36/42	36/42	30/36				
40 / 27	48/60	48/60	42/60	42/54	42/48	42/48	36/42	48/54	48/54	42/54	42/48	36/42	36/42	30/36	48/54	48/54	42/54	42/48	36/42	36/42	30/36				
50 / 34	40/54	40/54	40/54	40/54	40/48	40/48	36/42	40/48	40/48	40/48	40/48	36/42	36/42	30/36	40/48	40/48	40/48	40/48	36/42	36/42	30/36				
60 / 41	36/48	36/48	36/48	36/48	36/48	36/48	36/42	36/48	36/48	36/48	36/48	36/42	36/42	30/36	36/48	36/48	36/48	36/48	36/42	36/42	30/36				
70 / 47	32/42	32/42	32/42	32/42	32/42	32/36	32/36	32/42	32/42	32/42	32/42	32/36	32/36	30/36	32/42	32/42	32/36	32/36	32/36	30/36	30/36				
80 / 54	30/42	30/42	30/42	30/42	30/36	30/36	30/36	30/42	30/42	30/42	30/42	30/36	30/36	30/36	30/42	30/42	30/36	30/36	30/36	30/36	30/36				
90 / 61	24	24	24	24	24	24	24	24	24	24	24	24	24	24	24	24	24	24	24	24	24				
30 / 20	60	60	54/60	54	48	42/48	36/42	54/60	48/54	42/54	42/48	36/48	36/42	30/36	54/60	48/54	42/54	42/48	36/48	36/42	30/42				
40 / 27	48/60	48/60	42/60	42/54	42/48	42/48	36/42	48/54	48/54	42/54	42/48	36/48	36/42	30/36	48/54	48/54	42/54	42/48	36/48	36/42	30/42				
50 / 34	40/54	40/54	40/54	40/54	40/48	40/48	36/42	40/48	40/48	40/48	40/48	36/48	36/42	30/36	40/48	40/48	40/48	40/48	36/48	36/42	30/42				
60 / 41	36/48	36/48	36/48	36/48	36/48	36/48	36/42	36/48	36/48	36/48	36/48	36/42	36/42	30/36	36/48	36/48	36/48	36/48	36/42	36/42	30/42				
70 / 47	32/42	32/42	32/42	32/42	32/42	32/36	32/36	32/42	32/42	32/42	32/42	32/36	32/36	30/36	32/42	32/42	32/36	32/36	32/36	30/36	30/36				
80 / 54	30/42	30/42	30/42	30/42	30/36	30/36	30/36	30/42	30/42	30/42	30/42	30/36	30/36	30/36	30/42	30/42	30/36	30/36	30/36	30/36	30/36				
90 / 61	24	24	24	24	24	24	24	24	24	24	24	24	24	24	24	24	24	24	24	24	24				

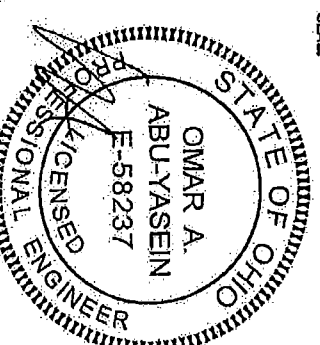NOTES:


1. FRAME SPACINGS ARE IN UNITS OF INCHES (IN).
2. WHERE TWO VALUES ARE SHOWN, THE HIGHER VALUE CAN ONLY BE USED FOR VERTICAL SHEATHING.
3. SNOW LOADS AND ROOF LIVE LOADS ARE IN POUNDS PER SQUARE FOOT (PSF). WIND SPEED IS 3 SEC. GUST IN MILES PER HOUR (MPH).
4. FOR VALUES THAT LIE BETWEEN TWO CELLS, THE HIGHER (MORE STRINGENT) VALUE HAS TO BE USED. INTERPOLATION BETWEEN CELLS IS NOT ALLOWED.

ENCLOSURE CLASSIFICATION:


1. ENCLOSED BUILDING = ALL 4 WALLS FULLY ENCLOSED WITH DOORS/WINDOWS = USE ENCLOSED BUILDING SPACING CHART.
2. OPEN BUILDING = ALL 4 WALLS FULLY OPEN = USE OPEN BUILDING SPACING CHART.
3. 3PT PARTIALLY ENCLOSED = BOTH END-WALLS FULLY OPEN, WITH BOTH SIDE-WALLS ONLY 3PT ENCLOSED = USE OPEN BUILDING SPACING CHART.
4. PARTIALLY ENCLOSED = BOTH END-WALLS FULLY OPEN, WITH BOTH SIDE-WALLS ENCLOSED MORE THAN 3FT = START WITH OPEN BUILDING SPACING CHART AND THEN REDUCE SPACING BY 6".
5. 5 SIDED ENCLOSED = ALL WALLS ARE ENCLOSED EXCEPT FOR 1 END-WALL = START WITH ENCLOSED BUILDING SPACING CHART. THE OPEN END FRAME MUST HAVE EITHER A GABLED END OR HAVE DOUBLED WEIDED LEGS & ROOF.
6. FOR ALL SHEATHING ENCLOSURES NOT LISTED ABOVE, REFER TO SHEET 5 FOR SPACING AND DESIGN REQUIREMENTS.

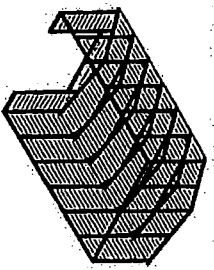

TYP. ENCLOSED BUILDING
SCALE: 1/8" = 1'-0"

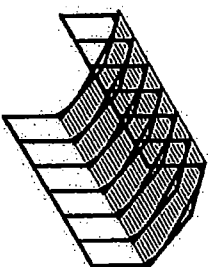


TYP. OPEN BUILDING
SCALE: 1/8" = 1'-0"

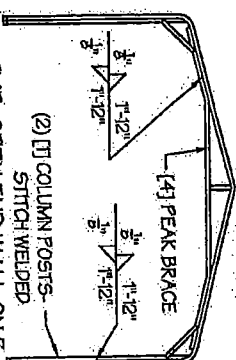

TYP. OPEN END WALL ON 5
SIDE ENCLOSED BUILDING
SCALE: 1/8" = 1'-0"

- GENERAL NOTES:
1. THE MAX. BUILDING LENGTH FOR ENCLOSED BUILDINGS IS 50'-0". THIS CAN BE INCREASED BY ADDING A DOUBLE FRAME AT THE CENTER TO BREAK THE LENGTH OF THE BUILDING.
 2. BUILDINGS WITH PARTIALLY ENCLOSED END WALLS NEED TO HAVE SIDE WALL BRACING TO SUPPORT THE PARTIALLY ENCLOSED END WALL. (SEE FIGURE A ON SHEET 5).

MANUFACTURED BY:

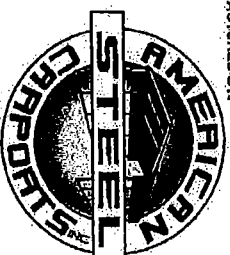

457 N. Broadway,
Joshua, TX 76058
1-866-730-9865

ENGINEERED BY:



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DRAWING INFORMATION

PROJECT: 26'-0" WIDE BUILDINGS
LOCATION: STATE OF OHIO
PROJECT NO.: 033-23-0120
SHEET TITLE:
SPACING SCHEDULES
& ENCLOSURE NOTES

SHEET NO.: 4 / 11


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SEAL:



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DATE SIGNED: 01-26-2023

TABLE 5.1: PURLIN SPACING SCHEDULE

GROUND / ROOF LIVE LOAD (PSF)	WIND SPEED (MPH)									
	105	115	130	140	155	165	180	190	200	210
30/20	54	48	42	36	30	24	24	24	24	24
40/27	42	42	42	36	30	24	24	24	24	24
50/34	40	40	40	36	30	24	24	24	24	24
60/41	36	36	36	36	30	24	24	24	24	24
70/47	32	32	32	32	30	24	24	24	24	24
80/54	30	30	30	30	30	24	24	24	24	24
90/61	24	24	24	24	24	24	24	24	24	24
30/20	54	48	42	36	30	24	24	24	24	24
40/27	42	42	42	36	30	24	24	24	24	24
50/34	40	40	40	36	30	24	24	24	24	24
60/41	36	36	36	36	30	24	24	24	24	24
70/47	32	32	32	32	30	24	24	24	24	24
80/54	30	30	30	30	30	24	24	24	24	24
90/61	24	24	24	24	24	24	24	24	24	24
30/20	54	48	42	36	30	24	24	24	24	24
40/27	42	42	42	36	30	24	24	24	24	24
50/34	40	40	40	36	30	24	24	24	24	24
60/41	36	36	36	36	30	24	24	24	24	24
70/47	32	32	32	32	30	24	24	24	24	24
80/54	30	30	30	30	30	24	24	24	24	24
90/61	24	24	24	24	24	24	24	24	24	24
30/20	54	48	42	36	30	24	24	24	24	24
40/27	42	42	42	36	30	24	24	24	24	24
50/34	40	40	40	36	30	24	24	24	24	24
60/41	36	36	36	36	30	24	24	24	24	24
70/47	32	32	32	32	30	24	24	24	24	24
80/54	30	30	30	30	30	24	24	24	24	24
90/61	24	24	24	24	24	24	24	24	24	24
30/20	54	48	42	36	30	24	24	24	24	24
40/27	42	42	42	36	30	24	24	24	24	24
50/34	40	40	40	36	30	24	24	24	24	24
60/41	36	36	36	36	30	24	24	24	24	24
70/47	32	32	32	32	30	24	24	24	24	24
80/54	30	30	30	30	30	24	24	24	24	24
90/61	24	24	24	24	24	24	24	24	24	24

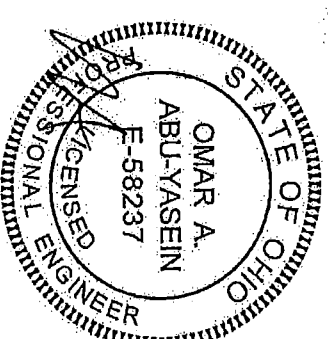NOTES:

1. PURLIN SPACING UNITS ARE IN INCHES.
2. FRAME SPACING NEEDS TO BE DETERMINED FROM TABLE 4.

IRREGULAR BUILDING NOTES:


1. FIGURES A, B, C & D ON THE RIGHT INDICATE EXAMPLES OF IRREGULAR BUILDINGS.
2. FOR IRREGULAR BUILDINGS, FRAME SPACING MUST BE REDUCED BY 6" FROM OPEN BUILDING SPACING TABLE. SEE SHEET 4 FOR OPEN BUILDING TABLE.
3. SITE SPECIFICS MAY ALLOW FOR ALTERNATIVE SPACING.

TABLE 5.2: GIRT SPACING SCHEDULE

FRAME SPACING	WIND SPEED (MPH)									
	105	115	130	140	155	165	180	190	200	210
05'-0"	60	48	36	30	24	24	24	24	24	24
04'-6"	60	48	42	36	30	24	24	24	24	24
04'-0"	60	60	54	54	42	36	30	24	24	24
03'-6"	60	60	54	54	48	42	36	30	24	24
02'-0" TO 3'-0"	60	60	54	54	48	42	36	30	24	24

NOTES:

1. GIRT SPACING UNITS ARE IN INCHES.
2. THIS SCHEDULE IS TO BE USED FOR BOTH 14GA.
3. FRAME SPACING NEEDS TO BE DETERMINED FROM TABLE 4.

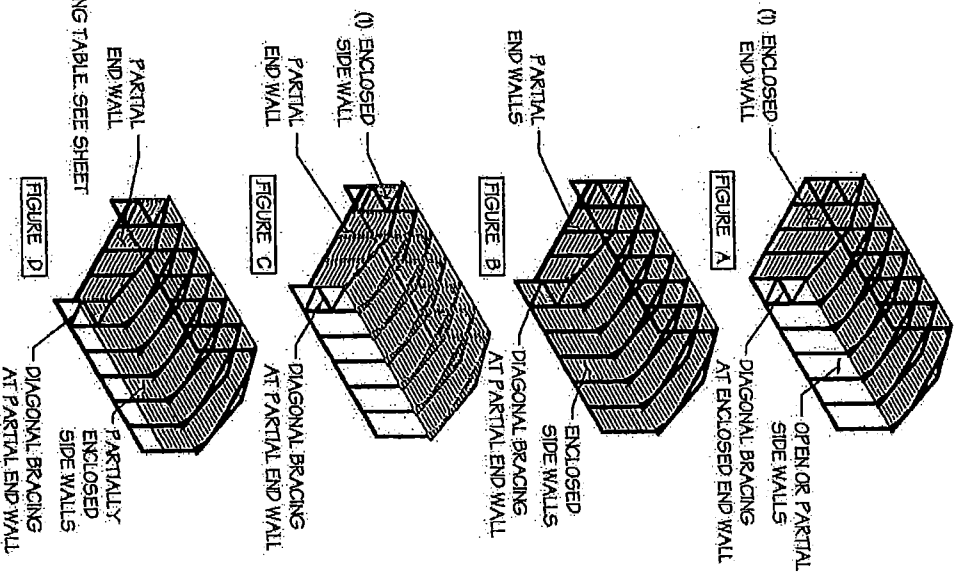

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DRAWING INFORMATION

PROJECT: 26'-0" WIDE BUILDINGS

LOCATION: STATE OF OHIO

PROJECT NO.: 033-23-0120

SHEET TITLE:

PURLIN & GIRT

SPACING SCHEDULES

SHEET NO.: 5 / 11


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CHECKED BY: OAA DATE: 1/24/22

LEGAL INFORMATION


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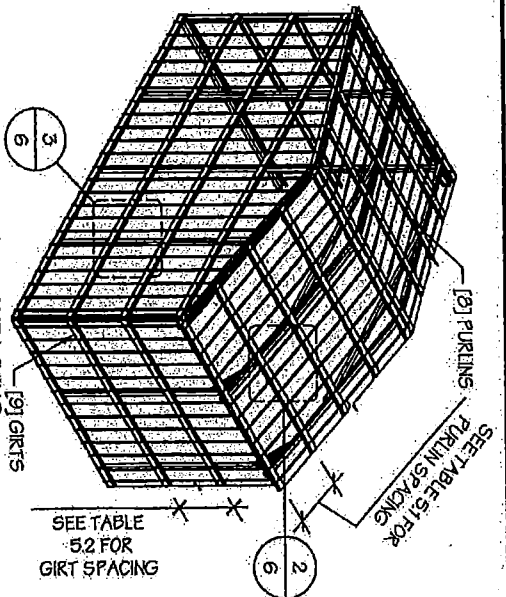


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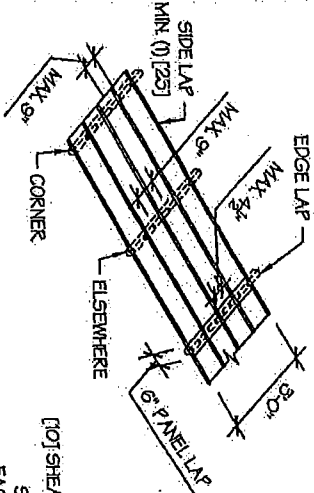


□ TYP. HORIZONTAL SHEATHING
SCALE: NTS

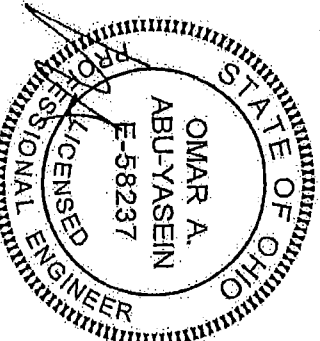


□ TYP. VERTICAL SHEATHING
SCALE: NTS

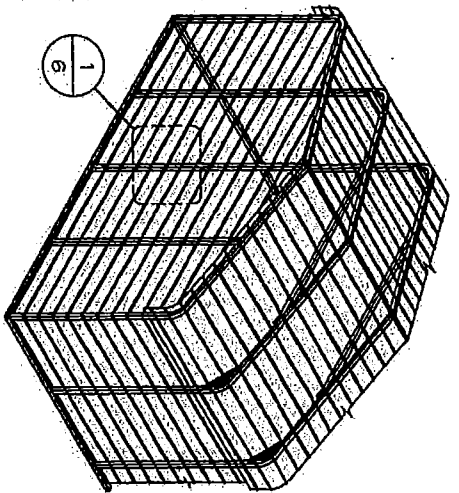
- GENERAL SHEATHING NOTES:**
1. REGULAR STYLE BUILDINGS CAN ONLY HAVE HORIZONTAL SHEATHING ON ROOF AND WALLS. A-FRAME STYLE BUILDINGS CAN HAVE ANY COMBINATION OF HORIZONTAL OR VERTICAL SHEATHING ON ROOFS AND WALLS. BOTH HORIZONTAL AND VERTICALS ROOF SHEATHING CAN HAVE MAX. 6" OVERHANG.
 2. USING VERTICAL SHEATHING MAY ALLOW FOR GREATER FRAME SPACING. SEE NOTE 2 UNDER TABLE 4.
 3. VERTICAL SHEATHING IS RECOMMENDED FOR BUILDINGS 30' OR LONGER.




TYP. SHEATHING FASTENER SCHEDULE
SCALE: NTS

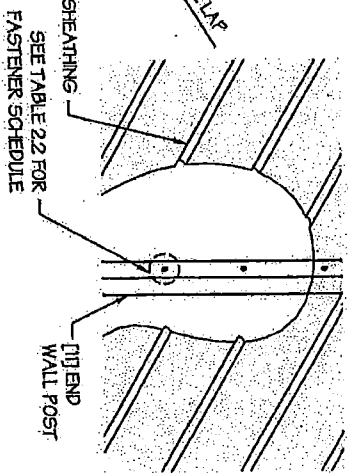


TYP. HORIZONTAL SHEATHING DETAIL
SCALE: NTS

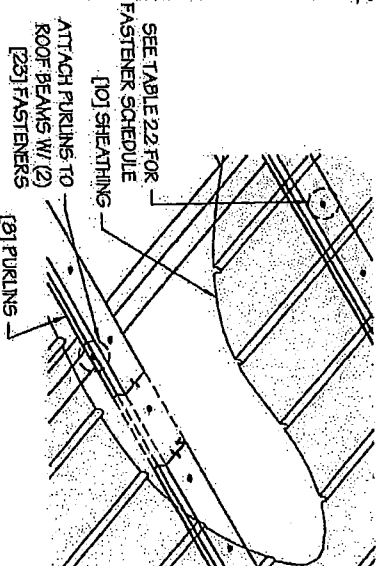

ROOF VERTICAL SHEATHING DETAIL
SCALE: NTS

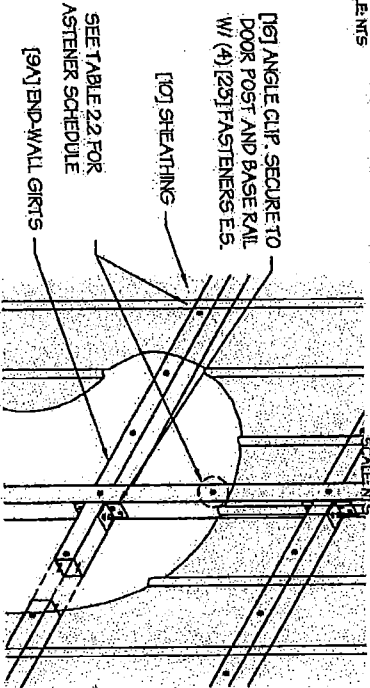


□ WALL VERTICAL SHEATHING - TUBE DETAIL
SCALE: NTS

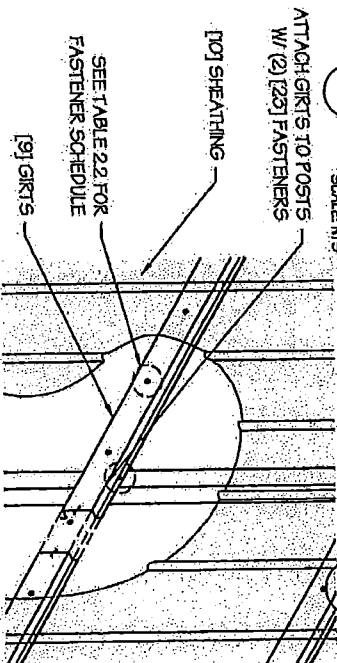

□ WALL VERTICAL SHEATHING - HAT CHANNEL DETAIL
SCALE: NTS

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DRAWING INFORMATION

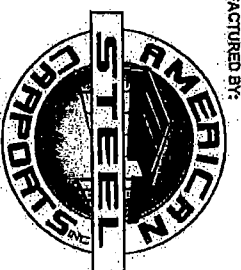PROJECT: 26'-0" WIDE BUILDINGS
LOCATION: STATE OF OHIO
PROJECT NO.: 033-23-0120
SHEET TITLE:
SHEATHING OPTIONS
& DETAILS

SHEET NO.: 6 / 11


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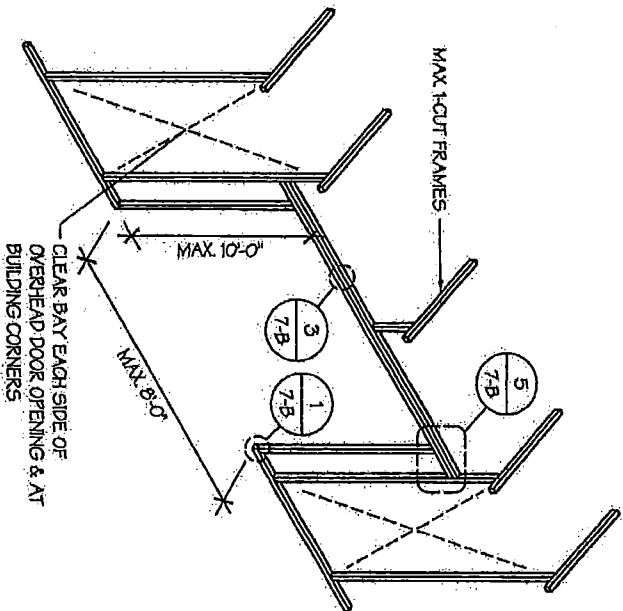
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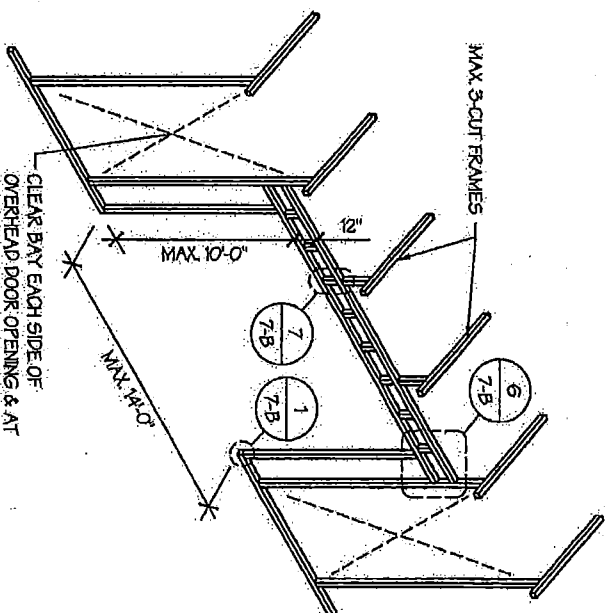


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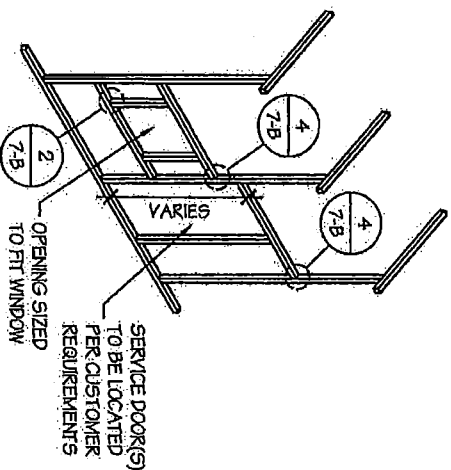
☐ SIDE WALL OVERHEAD DOOR OPENINGS

SCALE: NTS



☐ SIDE WALL OVERHEAD DOOR OPENINGS WITH TRUSS STYLE HEADER

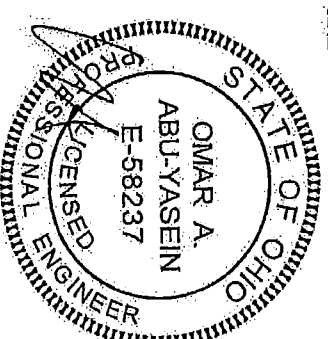SCALE: NTS



☐ SIDE WALL SERVICE DOOR / WINDOW OPENINGS

SCALE: NTS

SIDE WALL FRAMING NOTES:

1. TRUSS-STYLE HEADERS ARE REQUIRED FOR WHERE THE GROUND SNOW LOAD IS 40 PSF OR GREATER.
2. DESIGNS AND DETAILS SHOWN HERE ARE APPLICABLE TO BOTH REGULAR AND A-FRAME STYLE BUILDINGS.
3. MAX HEIGHT OF SIDE WALL OVERHEAD DOOR OPENINGS IS 2 FT LESS THAN THE EAVE HEIGHT.
4. OVERHEAD DOOR OPENINGS CANNOT CUT THROUGH MORE THAN 2 FULL FRAMES.
5. MIN 1 CLEAR BAY MUST BE MAINTAINED BETWEEN ANY 2 OVERHEAD DOOR OPENINGS. A CLEAR BAY IS A SPACE BETWEEN TWO FRAMES THAT HAS NO OVERHEAD DOOR OPENINGS.
6. MIN 1 CLEAR BAY MUST ALSO BE MAINTAINED FROM THE BUILDING CORNERS.
7. SERVICE DOORS AND WINDOWS CAN BE PLACED IN CLEAR BAYS OR ANY WHERE ELSE AS NEEDED.

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DRAWING INFORMATION

PROJECT: 26'-0" WIDE BUILDINGS

LOCATION: STATE OF OHIO

PROJECT NO.: 033-23-0120

SHEET TITLE

SIDE WALL FRAMING
& OPENINGS

SHEET NO.: 7-A / 11


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DRAWING INFORMATION

PROJECT: 26'-0" WIDE BUILDINGS

LOCATION: STATE OF OHIO

PROJECT NO.: 053-23-0120

SHEET NO.:

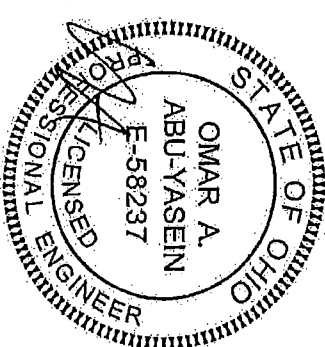SIDE WALL FRAMING
DETAILS

SHEET NO.: 7-B / 11


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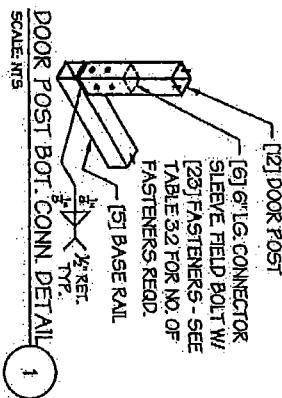
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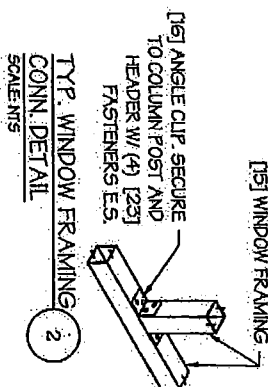
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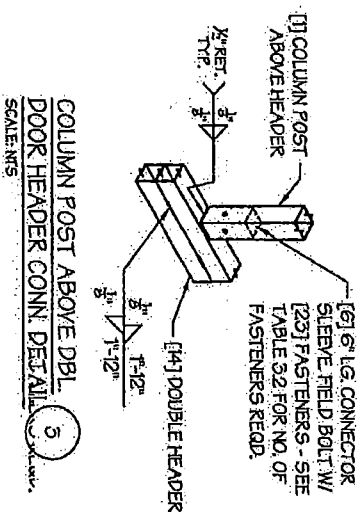
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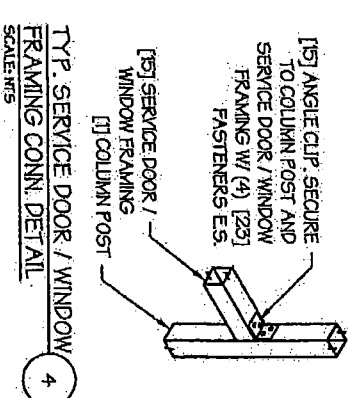
DOOR POST BOT. CONN. DETAIL
SCALE: NTS




TYP. WINDOW FRAMING
CONN. DETAIL
SCALE: NTS




COLUMN POST ABOVE DBL.
DOOR HEADER CONN. DETAIL
SCALE: NTS

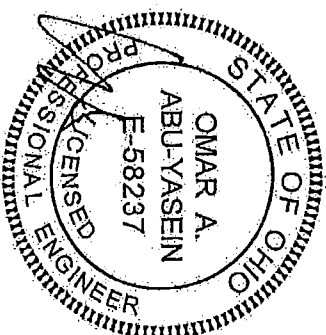


TYP. SERVICE DOOR / WINDOW
FRAMING CONN. DETAIL
SCALE: NTS

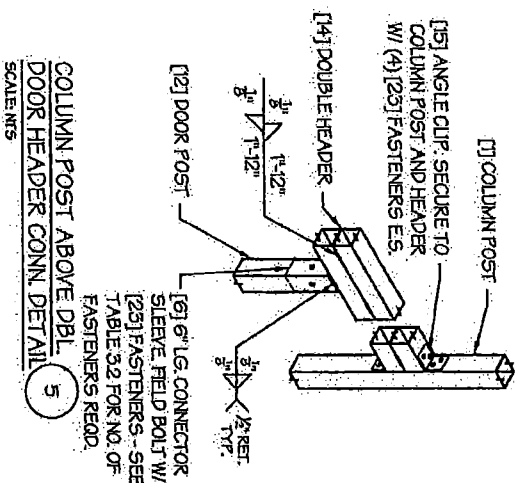

COLUMN POST ABOVE DBL.
DOOR HEADER CONN. DETAIL
SCALE: NTS

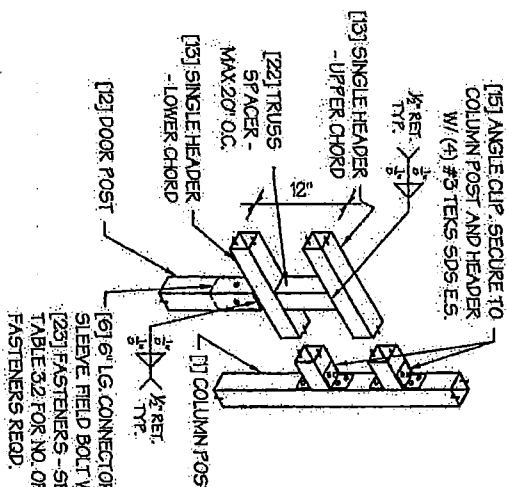

COLUMN POST ABOVE TRUSS
DOOR HEADER CONN. DETAIL
SCALE: NTS

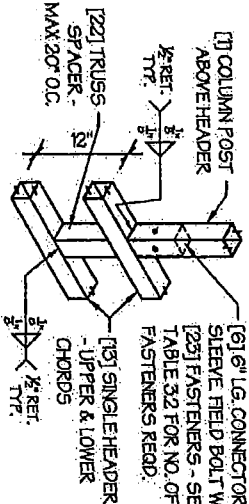

COLUMN POST ABOVE TRUSS
DOOR HEADER CONN. DETAIL
SCALE: NTS

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LOCATION: STATE OF OHIO
PROJECT NO.: 053-23-0120
SHEET TITLE:


END WALL FRAMING

SHEET NO.: B-A / 11
DRAWN BY: AW DATE: 1/24/22
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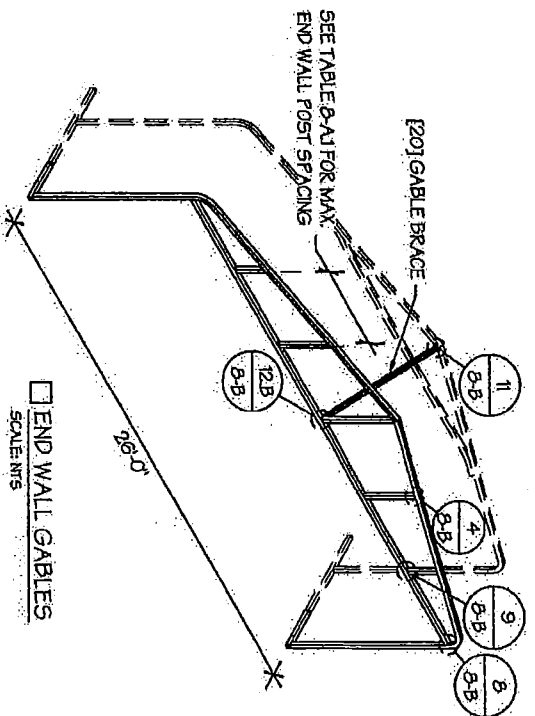
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END WALL OVERHEAD DOOR OPENINGS






TABLE B-A.1: END WALL POST SPACING SCHEDULE

WIND SPEED (MPH)	UP TO 7'	8' TO 9'	10' TO 12'
105	5'	5'	5'
115	5'	5'	4.5'
130	4.5'	4.5'	4'
140	4.5'	4.5'	3'
155	4'	4'	2.5'
165 - 180	3.5'	3'	2'

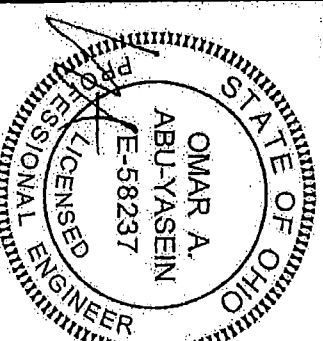- #### GABLE BRACING NOTE
- GABLE BRACE IS ONLY REQUIRED FOR PARTIALLY ENCLOSED END WALLS (END WALL POSTS ARE NOT ANCHORED TO THE GROUND).
 - FULLY ENCLOSED OR OPEN END WALLS DO NOT REQUIRE GABLE BRACING.
- #### END WALL FRAMING NOTES:
- DESIGNS AND DETAILS SHOWN HERE ARE APPLICABLE TO BOTH REGULAR AND A-FRAME STYLE BUILDINGS.
 - MIN. 12" CLEARANCE MUST BE MAINTAINED BETWEEN ANY TWO OPENINGS (OVERHEAD DOOR OR SERVICE DOOR) AND FROM CORNERS.
 - SERVICE DOORS AND WINDOWS CAN BE PLACED AS NEEDED.
 - DIAGONAL BRACES NEED TO BE ADDED FOR PARTIAL END WALL ENCLOSURES. SEE SHEET 9 FOR DIAGONAL BRACE CONNECTION DETAILS.

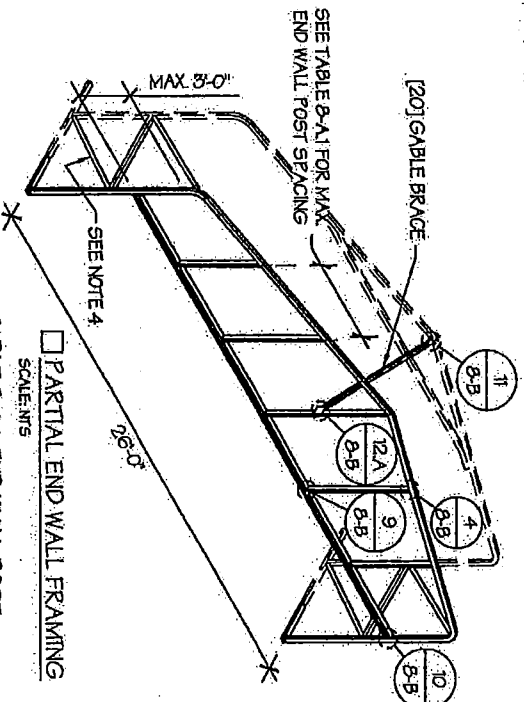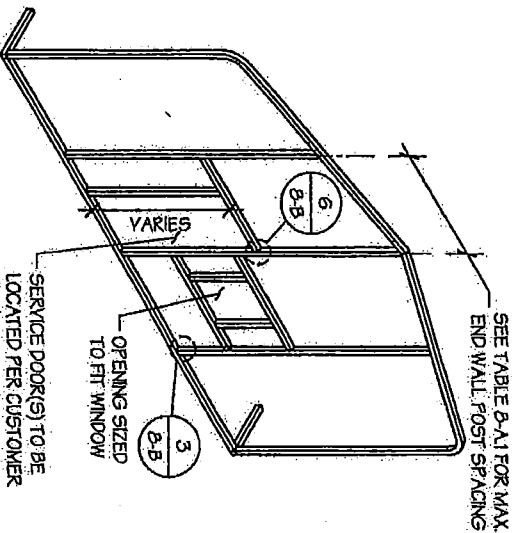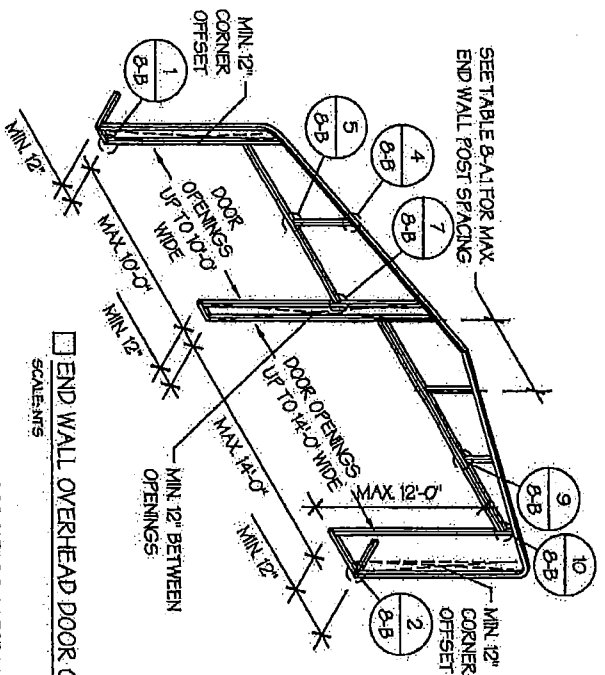

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PROJECT: 26'-0" WIDE BUILDINGS
LOCATION: STATE OF OHIO
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SHEET TITLE:


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DETAILS

SHEET NO.: 8-B / 11
DRAWN BY: AW DATE: 1/24/22
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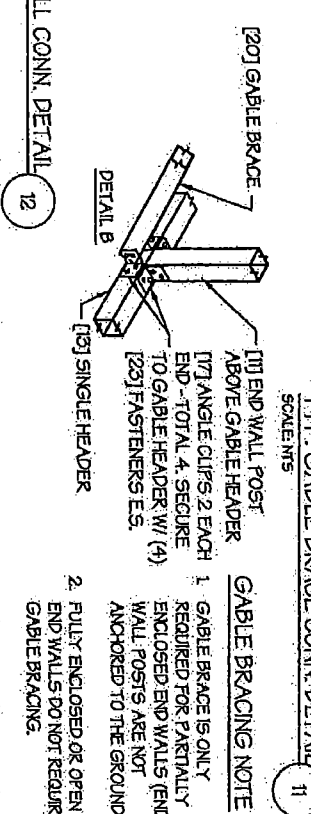
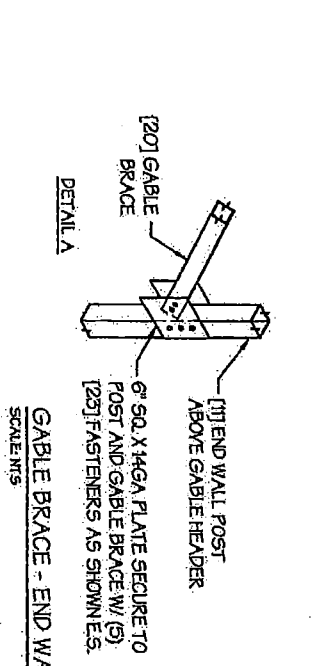
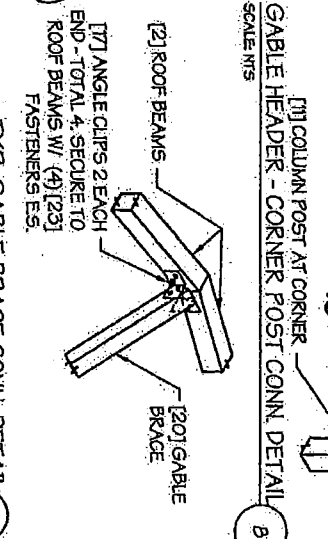
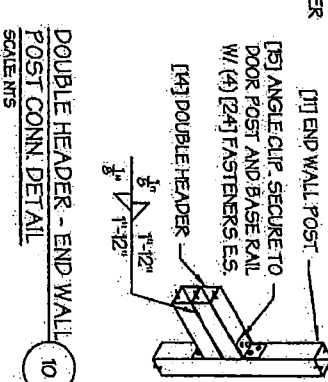
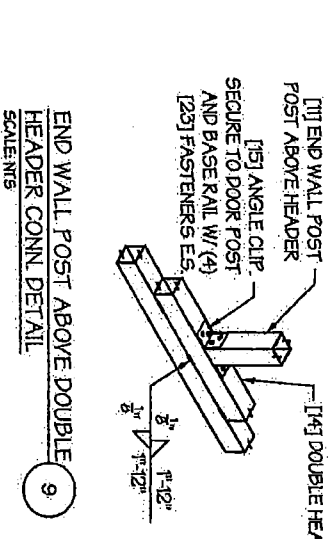
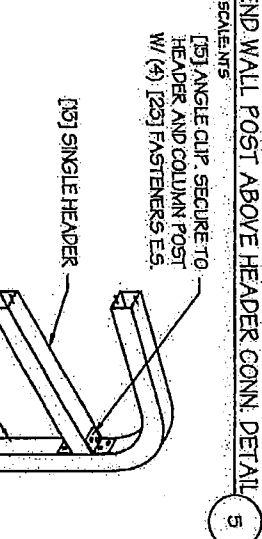
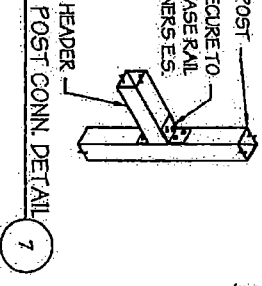
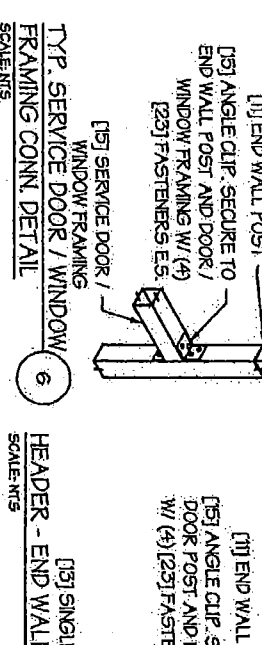
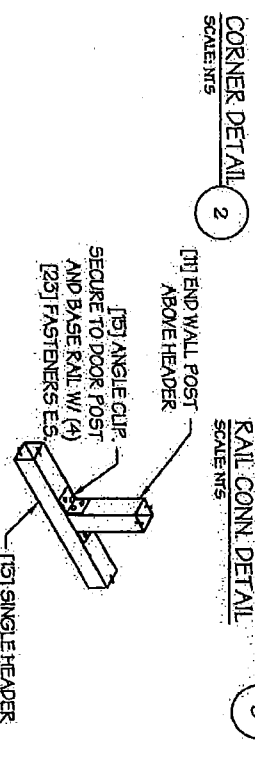
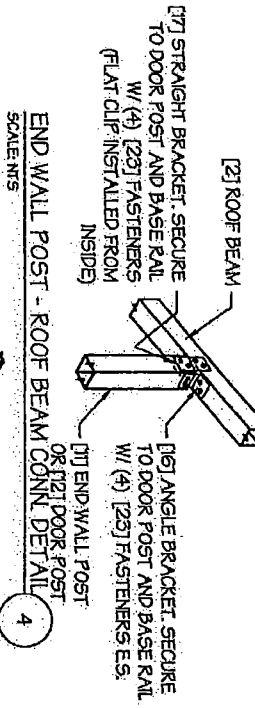
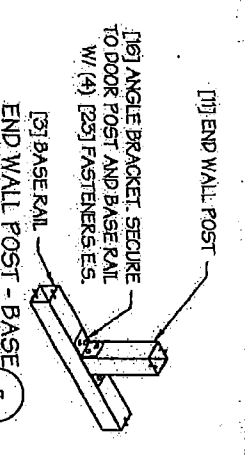
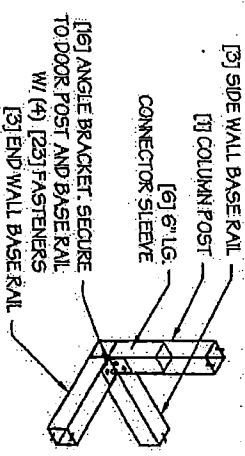
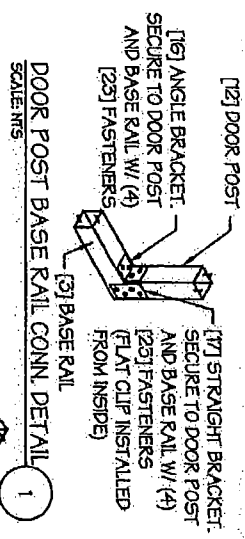
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GABLE BRACING NOTE

1. GABLE BRACE IS ONLY REQUIRED FOR PARTIALLY ENCLOSED END WALLS (END WALL POSTS ARE NOT ANCHORED TO THE GROUND).
2. FULLY ENCLOSED OR OPEN END WALLS DO NOT REQUIRE GABLE BRACING.

CONCRETE SLAB FOUNDATION NOTES:

- DESIGNS SHOWN ON THIS SHEET ARE FOR CONCRETE SLAB FOUNDATION. ANY OF THE FOUNDATIONS SHOWN ON SHEETS 11-A THRU D CAN BE USED.
- CONCRETE ANCHORS SHALL BE LOCATED NEXT TO EVERY POST AND ON EITHER SIDE OF OPENINGS. TWO ANCHORS SHALL BE INSTALLED AT CORNERS OF ENCLOSED BUILDINGS WITH END WALLS - ONE ON EACH BASE RAIL. IN LOCATIONS REQUIRING TWO ANCHORS DUE TO WIND, ONE ANCHOR IS TO BE ON EACH SIDE OF THE COLUMN POST.
- ANCHORS IN CLOSE PROXIMITY TO EACH OTHER MUST HAVE A MIN. 4" SPACING.
- MIN. NUMBER OF CONCRETE ANCHORS PER POST SHALL BE AS SHOWN IN TABLE 11-A2.
- THE SIZE OF THE SLAB SHALL BE THE SIZE (WIDTH AND LENGTH) OF THE BUILDING PLUS 5" FOR 14GA MATERIAL AND 5" FOR 12GA MATERIAL.
- DEPTH OF SLAB TURN DOWN FOOTING SHALL BE GREATER THAN FROST DEPTH SPECIFIED PER LOCAL CODE.
- CONTROL JOINTS SHALL BE PLACED SO AS TO LIMIT MAX. SLAB SPANS TO 20' IN EACH DIRECTION.
- ASSUMED SOIL BEARING CAPACITY IS TO BE A MIN. OF 1500 PSF.
- CONCRETE STRENGTH TO BE A MIN. OF 2500 PSI @ 28 DAYS.

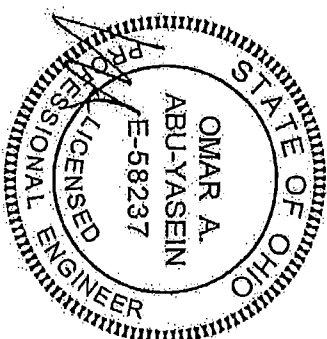CONCRETE SLAB FOUNDATION

SCALE: NTS

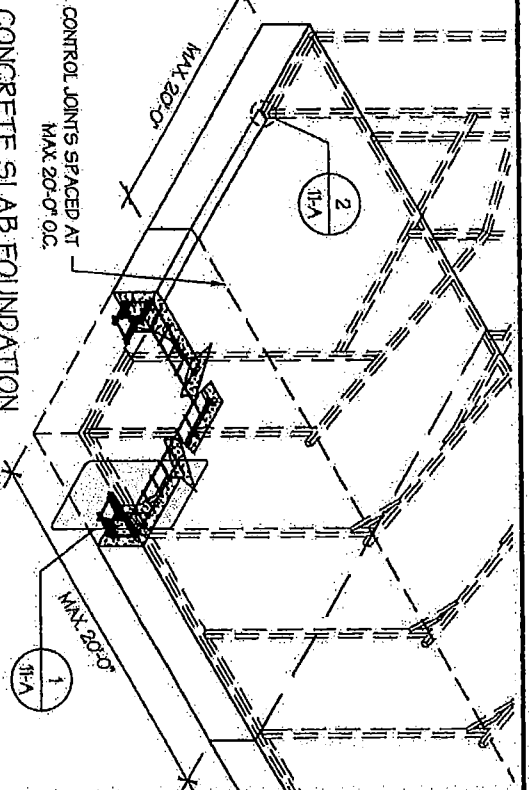


TABLE 11-A2: CONCRETE SLAB ANCHOR SCHEDULE

ENCLOSURE	WIND SPEED (MPH)	ANCHOR SIZE/NUMBER
ENCLOSED	105 TO 135	(1) 1/2" X 7"
	136 TO 160	(2) 1/2" X 7"
OPEN	105 TO 135	(1) 1/2" X 7"
	136 TO 160	(2) 1/2" X 7"

NOTES:

- ANCHORS ARE TO BE CONCRETE WEDGE OR EXPANSION ANCHORS.
- MIN. EMBEDMENT DEPTH TO BE 2x.
- ANCHORS TO BE SPACED NO MORE THAN 6" FROM POSTS.

OVERHEAD DOOR NOTCH DETAIL

SCALE: NTS

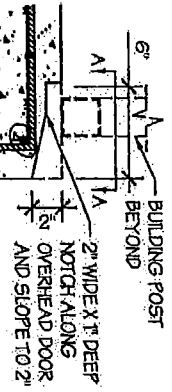


TABLE 11-A1: NOTCH WIDTH

HORIZONTAL/OPEN	VERTICAL
14GA	12GA
2 3/4"	2 7/8"
	1 3/4"
	1 7/8"

NOTE: DEPTHS TO BE 1 1/2"

TABLE 11-A2: CONCRETE SLAB ANCHOR SCHEDULE

ENCLOSURE	WIND SPEED (MPH)	ANCHOR SIZE/NUMBER
ENCLOSED	105 TO 135	(1) 1/2" X 7"
	136 TO 160	(2) 1/2" X 7"
OPEN	105 TO 135	(1) 1/2" X 7"
	136 TO 160	(2) 1/2" X 7"

NOTES:

- ANCHORS ARE TO BE CONCRETE WEDGE OR EXPANSION ANCHORS.
- MIN. EMBEDMENT DEPTH TO BE 2x.
- ANCHORS TO BE SPACED NO MORE THAN 6" FROM POSTS.

TABLE 11-A2: CONCRETE SLAB ANCHOR SCHEDULE



ENCLOSURE	WIND SPEED (MPH)	ANCHOR SIZE/NUMBER
ENCLOSED	105 TO 135	(1) 1/2" X 7"
	136 TO 160	(2) 1/2" X 7"
OPEN	105 TO 135	(1) 1/2" X 7"
	136 TO 160	(2) 1/2" X 7"

NOTES:

- ANCHORS ARE TO BE CONCRETE WEDGE OR EXPANSION ANCHORS.
- MIN. EMBEDMENT DEPTH TO BE 2x.
- ANCHORS TO BE SPACED NO MORE THAN 6" FROM POSTS.

EDGE OFFSET DETAIL

SCALE: NTS

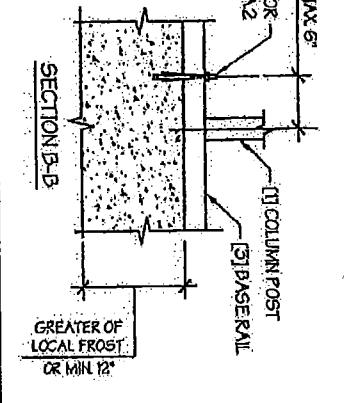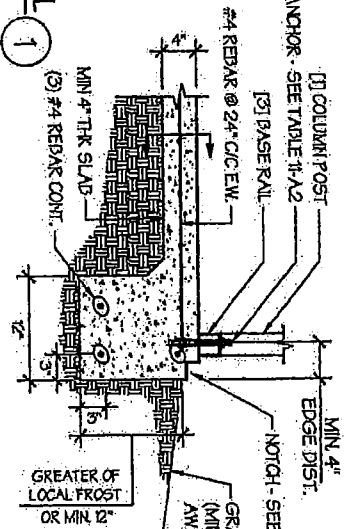

457 N. Broadway,
Joshua, TX 76058
1-866-730-9865



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CIVIL - STRUCTURAL
6085 Renaissance Pkwy., Toledo, OH 43623
Tel: 419-292-1983 • Fax: 419-292-0555
www.a-a-engineers.com


DRAWING INFORMATION

PROJECT: 26'-0" WIDE BUILDINGS
LOCATION: STATE OF OHIO
PROJECT NO.: 033-23-0120
SHEET TITLE:
FOUNDATION OPTION 1:
CONCRETE SLAB
SHEET NO.: 11-A / 11
DRAWN BY: AW DATE: 1/24/22
CHECKED BY: OAA DATE: 1/24/22

LEGAL INFORMATION

ANY REPLICATION OF THIS DRAWING IN WHOLE OR PART IS STRICTLY FORBIDDEN. ANYONE DOING SO WILL BE PROSECUTED UNDER THE FULL EXTENT OF THE LAW.
DRAWINGS VALID UP TO DATE OF EXPIRATION.

SEAL:

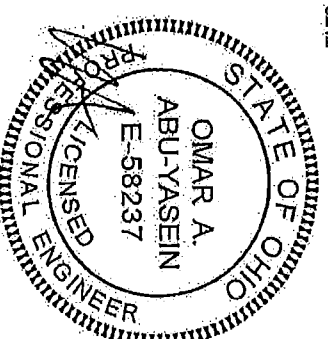

STAMP EXPIRY: 12-31-2023
DATE SIGNED: 01-26-2023

ORDINANCE NO. 002-2024

APPROVING AND MAKING A SUPPLEMENTAL APPROPRIATION IN THE AMOUNT OF EIGHT THOUSAND TWO HUNDRED EIGHTEEN AND 20/100 DOLLARS (\$8,218.20) FROM UNAPPROPRIATED MONIES IN POLICE DEPARTMENT GRANT FUND (212) TO THE 212.000.50050 PD GRANT FUND CADET INTERNSHIP PROGRAM EXPENSE ACCOUNT AND DECLARING AN EMERGENCY.

WHEREAS, the City of Whitehall Division of Police was awarded a reimbursement grant for cadet internship in the amount of fourteen thousand and 00/100 dollars (\$14,000.00) in 2023 and;

WHEREAS, the City of Whitehall Division of Police paid five thousand seven hundred eighty-one and 80/100 dollars (\$5,781.80) to the cadets in 2023 and;

WHEREAS, the City of Whitehall Division Police needs to appropriate the remaining eight thousand two hundred eighteen and 20/00 dollars (\$8,218.20) to the expense account for 2024; NOW, THEREFORE,

BE IT ORDAINED BY THE COUNCIL OF THE CITY OF WHITEHALL, OHIO:

SECTION 1: The Council of the City of Whitehall, Ohio approves and makes a supplemental appropriation in the amount of eight thousand two hundred eighteen and 20/00 dollars (\$8,218.20) from unappropriated monies in the Police Department Grant Fund (212) to the PD Grant Fund Cadet Internship Program Expense Account 212.000.50050.

SECTION 2: That the City Auditor is hereby authorized to draw his warrant upon the Treasurer of the City for these funds for the purpose stated.

SECTION 3: That this Ordinance is hereby declared to be an emergency measure immediately necessary for the preservation of the public health, peace, safety and welfare of the community, and for further reason these funds need to be recorded into the appropriate grant fund account; WHEREFORE, this ordinance shall go into full force and effect immediately upon its passage and approval by the Mayor.

PASSED this ____ day of _____, 2024.

ATTEST:

Clerk of Council

President of Council

APPROVED this ____ day of _____, 2024.

Mayor

ORDINANCE NO. 003-2024

AUTHORIZING EXEMPTIONS OF 161.09(A) VACATION AND SICK LEAVE CREDIT CARRYOVER 161.09(8) FOR THE PURPOSE OF EMPLOYING A HIGHLY QUALIFIED EMPLOYEE TO THE CITY OF WHITEHALL AND DECLARING AN EMERGENCY.

WHEREAS, the City of Whitehall has the opportunity to hire a highly qualified individual as Director of Development in the Mayor's office; and

WHEREAS, the employee has valuable economic development and public finance experience with eighteen years of experience and the City would like to offer a match for service for computing vacation leave; NOW, THEREFORE,

BE IT ORDAINED BY THE COUNCIL OF THE CITY OF WHITEHALL, OHIO:

SECTION 1: The Council of the City of Whitehall, Ohio authorizes a one-time exemption for 161.09(A) to match years of service, and to match these years of service as indicated in 161.15(b)(l) of the Codified Ordinances of the City of Whitehall.

SECTION 2: That this Ordinance is hereby declared to be an emergency measure immediately necessary for the preservation of the public health, peace, safety and welfare; and for the further reason to permit this employee to carry over his years of service; WHEREFORE, This Ordinance shall go into full force and effect immediately upon its passage and approval by the Mayor.

PASSED this ____ day of _____, 2024.

ATTEST:

Clerk of Council

President of Council

APPROVED this ____ day of _____, 2024.

Mayor

ORDINANCE NO. 004-2024

AUTHORIZING EXEMPTIONS OF 161.09(A) VACATION AND SICK LEAVE CREDIT CARRYOVER 161.09(8) FOR THE PURPOSE OF EMPLOYING A HIGHLY QUALIFIED EMPLOYEE TO THE CITY OF WHITEHALL AND DECLARING AN EMERGENCY.

WHEREAS, the City of Whitehall has the opportunity to hire a highly qualified individual as Administrative Assistant to the Mayor in the Mayor's office; and

WHEREAS, the employee has valuable public service experience with nine years of experience and the City would like to offer a match for service for computing vacation leave; NOW, THEREFORE,

BE IT ORDAINED BY THE COUNCIL OF THE CITY OF WHITEHALL, OHIO:

SECTION 1: The Council of the City of Whitehall, Ohio authorizes a one-time exemption for 161.09(A) to match years of service, and to match these years of service as indicated in 161.15(b)(l) of the Codified Ordinances of the City of Whitehall.

SECTION 2: That this Ordinance is hereby declared to be an emergency measure immediately necessary for the preservation of the public health, peace, safety and welfare; and for the further reason to permit this employee to carry over her years of service; WHEREFORE, This Ordinance shall go into full force and effect immediately upon its passage and approval by the Mayor.

PASSED this ____ day of _____, 2024.

ATTEST:

Clerk of Council

President of Council

APPROVED this ____ day of _____, 2024.

Mayor

RESOLUTION NO. 001-2024

AUTHORIZING THE MAYOR TO APPLY FOR AND ACCEPT ASSISTANCE FROM THE OHIO DEPARTMENT OF NATURAL RESOURCES VIA OHIO'S URBAN FORESTRY GRANT PROGRAM

WHEREAS, the Ohio Department of Natural Resources has reimbursable grants available from USDA Forest Service, from Inflation Reduction Act funding, intended to substantially invest in the long-term growth and development of local urban and community forestry programs; and

WHEREAS, the City of Whitehall desires to develop and execute a plan to protect its existing urban tree canopy and sustainably grow its public tree inventory; and

WHEREAS, the City of Whitehall desires to apply for and accept a reimbursable grant offered through the Ohio Department of Natural Resources in an amount not to exceed five hundred and fifty thousand and no/100 dollars (\$550,000); and

WHEREAS, the City of Whitehall is not required to provide any matching funds or in-kind services in order to accept said grant funding; NOW, THEREFORE,

BE IT RESOLVED BY THE COUNCIL OF THE CITY OF WHITEHALL, OHIO:

SECTION 1: That the Mayor is hereby authorized to apply for and accept an Ohio Urban Forestry Grant(s) in an amount not to exceed five hundred and fifty thousand and no/100 dollars (\$550,000).

SECTION 2: That the Mayor as Chief Executive Officer and Shannon Brady as Official Representative and Program Contact be directed and authorized to act in connection with the application.

SECTION 3: That this resolution shall take effect and be in force from the earliest period allowed by law.

PASSED this ____ day of _____, 2024.

ATTEST:

Clerk of Council

President of Council

APPROVED this ____ day of _____, 2024.

Mayor

RESOLUTION NO. 002-2024

A RESOLUTION TO ADOPT THE SOLID WASTE MANAGEMENT PLAN FOR THE SOLID WASTE AUTHORITY OF CENTRAL OHIO AND DECLARING AN EMERGENCY.

WHEREAS, the City of Whitehall (the "City") is located within the jurisdiction of the Solid Waste Authority of Central Ohio (SWACO); and

WHEREAS, the SWACO Board of Trustees prepared and adopted a final draft of the Solid Waste Management Plan in accordance with Ohio Revised Code Sections 3734.53, 3734.54, 3734.55 and 3734.56 on December 12, 2023; and

WHEREAS, SWACO has provided a copy of the Draft Final Solid Waste Management Plan for ratification to each of the legislative authorities of the District; and

WHEREAS, the City of Whitehall must decide whether is approves of said Solid Waste Management Plan within ninety days of receipt of the Final Draft Plan; and NOW, THEREFORE,

BE IT RESOLVED by the Council of the City of Whitehall, Franklin County, State of Ohio, __ of the elected members concurring that:

SECTION 1: The City approves the SWACO Solid Waste Management Plan.

SECTION 2: The Clerk is hereby directed to send SWACO a copy of this resolution to the attention of Andrew Booker, SWACO, 4239 London Groveport Rd., Grove City, OH 43123 or by email Andrew.booker@swaco.org.

SECTION 3: That is found and determined that all formal actions of the Council of the City of Whitehall, Franklin County, State of Ohio concerning and relating to the passage of this resolution were adopted in an open meeting of this Council and of any of its committees that resulted in such formal actions were in meetings open to the public in compliance with all legal requirements including Sections 121.22 of the Ohio Revised Code.

PASSED this ____ day of _____, 2024.

ATTEST:

Clerk of Council

President of Council

APPROVED this ____ day of _____, 2024

Mayor